# 06 - ELECTRICAL- ILLUMINATION INDEX OF DRAWINGS

DRAWING NUMBER	DRAWING TITLE	DRAWING NUMBER	DRAWING TITLE
ILL-01	INDEX OF DRAWINGS		
ILL-02	ILLUMINATION PLAN		
ILL-03	ELECTRICAL DETAILS		
ILL-04	CONDUIT EXPANSION FITTINGS		
ILL-05	STRUCTURE RELATED ELECTRICAL DETAILS		

THE DESIGN APPEARS TO CONFORM TO APPLICABLE CRITERIA. APPROVAL IS NOT TO BE CONSTRUED TO MEAN THAT ALL ASPECTS OF THE DESIGN HAVE BEEN PERSONALLY CHECKED BY THE UNDERSIGNED.

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-	-	-	-	QUANTITIES OF WORK, SHOWN ON THESE SHEETS IS BASED ON LIMITED	СН
-	-	-	-	INVESTIGATIONS BY THE STATE AND IS IN NO WAY WARRANTED TO INDICATE	
-	-	-	-	THE CONDITIONS OF ACTUAL QUANTITIES	
-	-	-	-	OF WORK WHICH WILL BE REQUIRED.	
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CKED BY: <b>JA</b>	STATE OF CONNECTICUT
	DEPARTMENT OF TRANSPORTATION

Amy M.D.

REPLACEMENT OF BRIDGE NO. 02374 SR 500 TR 805 OVER I-84 TR 831 TR 833 EAST HARTFORD

INDEX OF DRAWINGS

DRAWING NO.

ILL-01


SHEET NO.

01.06.01

042-304

#### ILLUMINATION NOTES:

- 1) THE CONTRACTOR SHALL CARRY OUT THE ELECTRICAL WORK IN SUCH A MANNER THAT THERE IS NO DISRUPTION IN THE PROPER NIGHTIME OPERATION OF THE HIGHWAY LIGHTING CIRCUIT. PRIOR TO THE DISCONNECTION OF THE EXISTING LIGHTING CIRCUIT, THE CONTRACTOR SHALL INSTALL THE NEW RMC IN THE SHOULDER, CONNECT TO THE EXISTING CONCRETE HANDHOLES, AND INSTALL THE NEW CONDUCTORS AS SHOWN. THE CONTRACTOR SHALL ONLY DISCONNECT THE EXISTING CONDUCTORS WHEN THE NEW CONDUCTORS HAVE BEEN INSTALLED AND READIED FOR FINAL CONNECTION. ALL CIRCUIT CONNECTIONS SHALL BE CARRIED OUT DURING DAYLIGHT HOURS.
- 2) EXISTING CIRCUITS ARE 480 VOLT, THREE PHASE, 3 WIRE. THE LIGHTING CONTROL CABINET IS LOCATED ON JUNE STREET IN EAST HARTFORD.
- 3) CONDUCTORS SHALL BE COPPER, INSULATION TYPE XHHW AND RATED FOR 600 VOLTS. INSULATION SHALL BE COLORED CROSS LINKED POLYETHELENE (XLP). THREE PHASE CIRCUIT COLORS SHALL BE AS FOLLOWS: BLUE, BLACK, RED.
- 4) INSTALL ONE NUMBER 8 BARE COPPER GROUNDING CONDUCTOR THROUGHOUT ALL LIGHTING CIRCUITS.
- 5) FOR EXISTING ILLUMINATION SEE STATE PROJECT 42-196.
- 6) THE CONTRACTOR SHALL CONTACT MR. AUGUSTO GRAZUNA OF DISTRICT 1 ELECTRICAL MAINTENANCE AT 860-566-3156 WHEN ACCESS TO THE LIGHTING CABINET IS REQUIRED. THE CONTRACTOR SHALL ABIDE BY THE CONNDOT LOCKOUT/TAGOUT PROCEDURES.
- 7) ALL ELECTRICAL WORK SHALL CONFORM TO THE NATIONAL ELECTRIC CODE, CONNECTICUT STANDARD SPECIFICATIONS, AND WHERE APPLICABLE, UTILITY COMPANY REGULATIONS.
- 8) TAPE ALL UNUSED CONDUCTORS.
- 9) CIRCUIT CONNECTIONS/SPLICES SHALL BE PAID FOR UNDER THE ITEM(S) FOR CONDUCTORS.

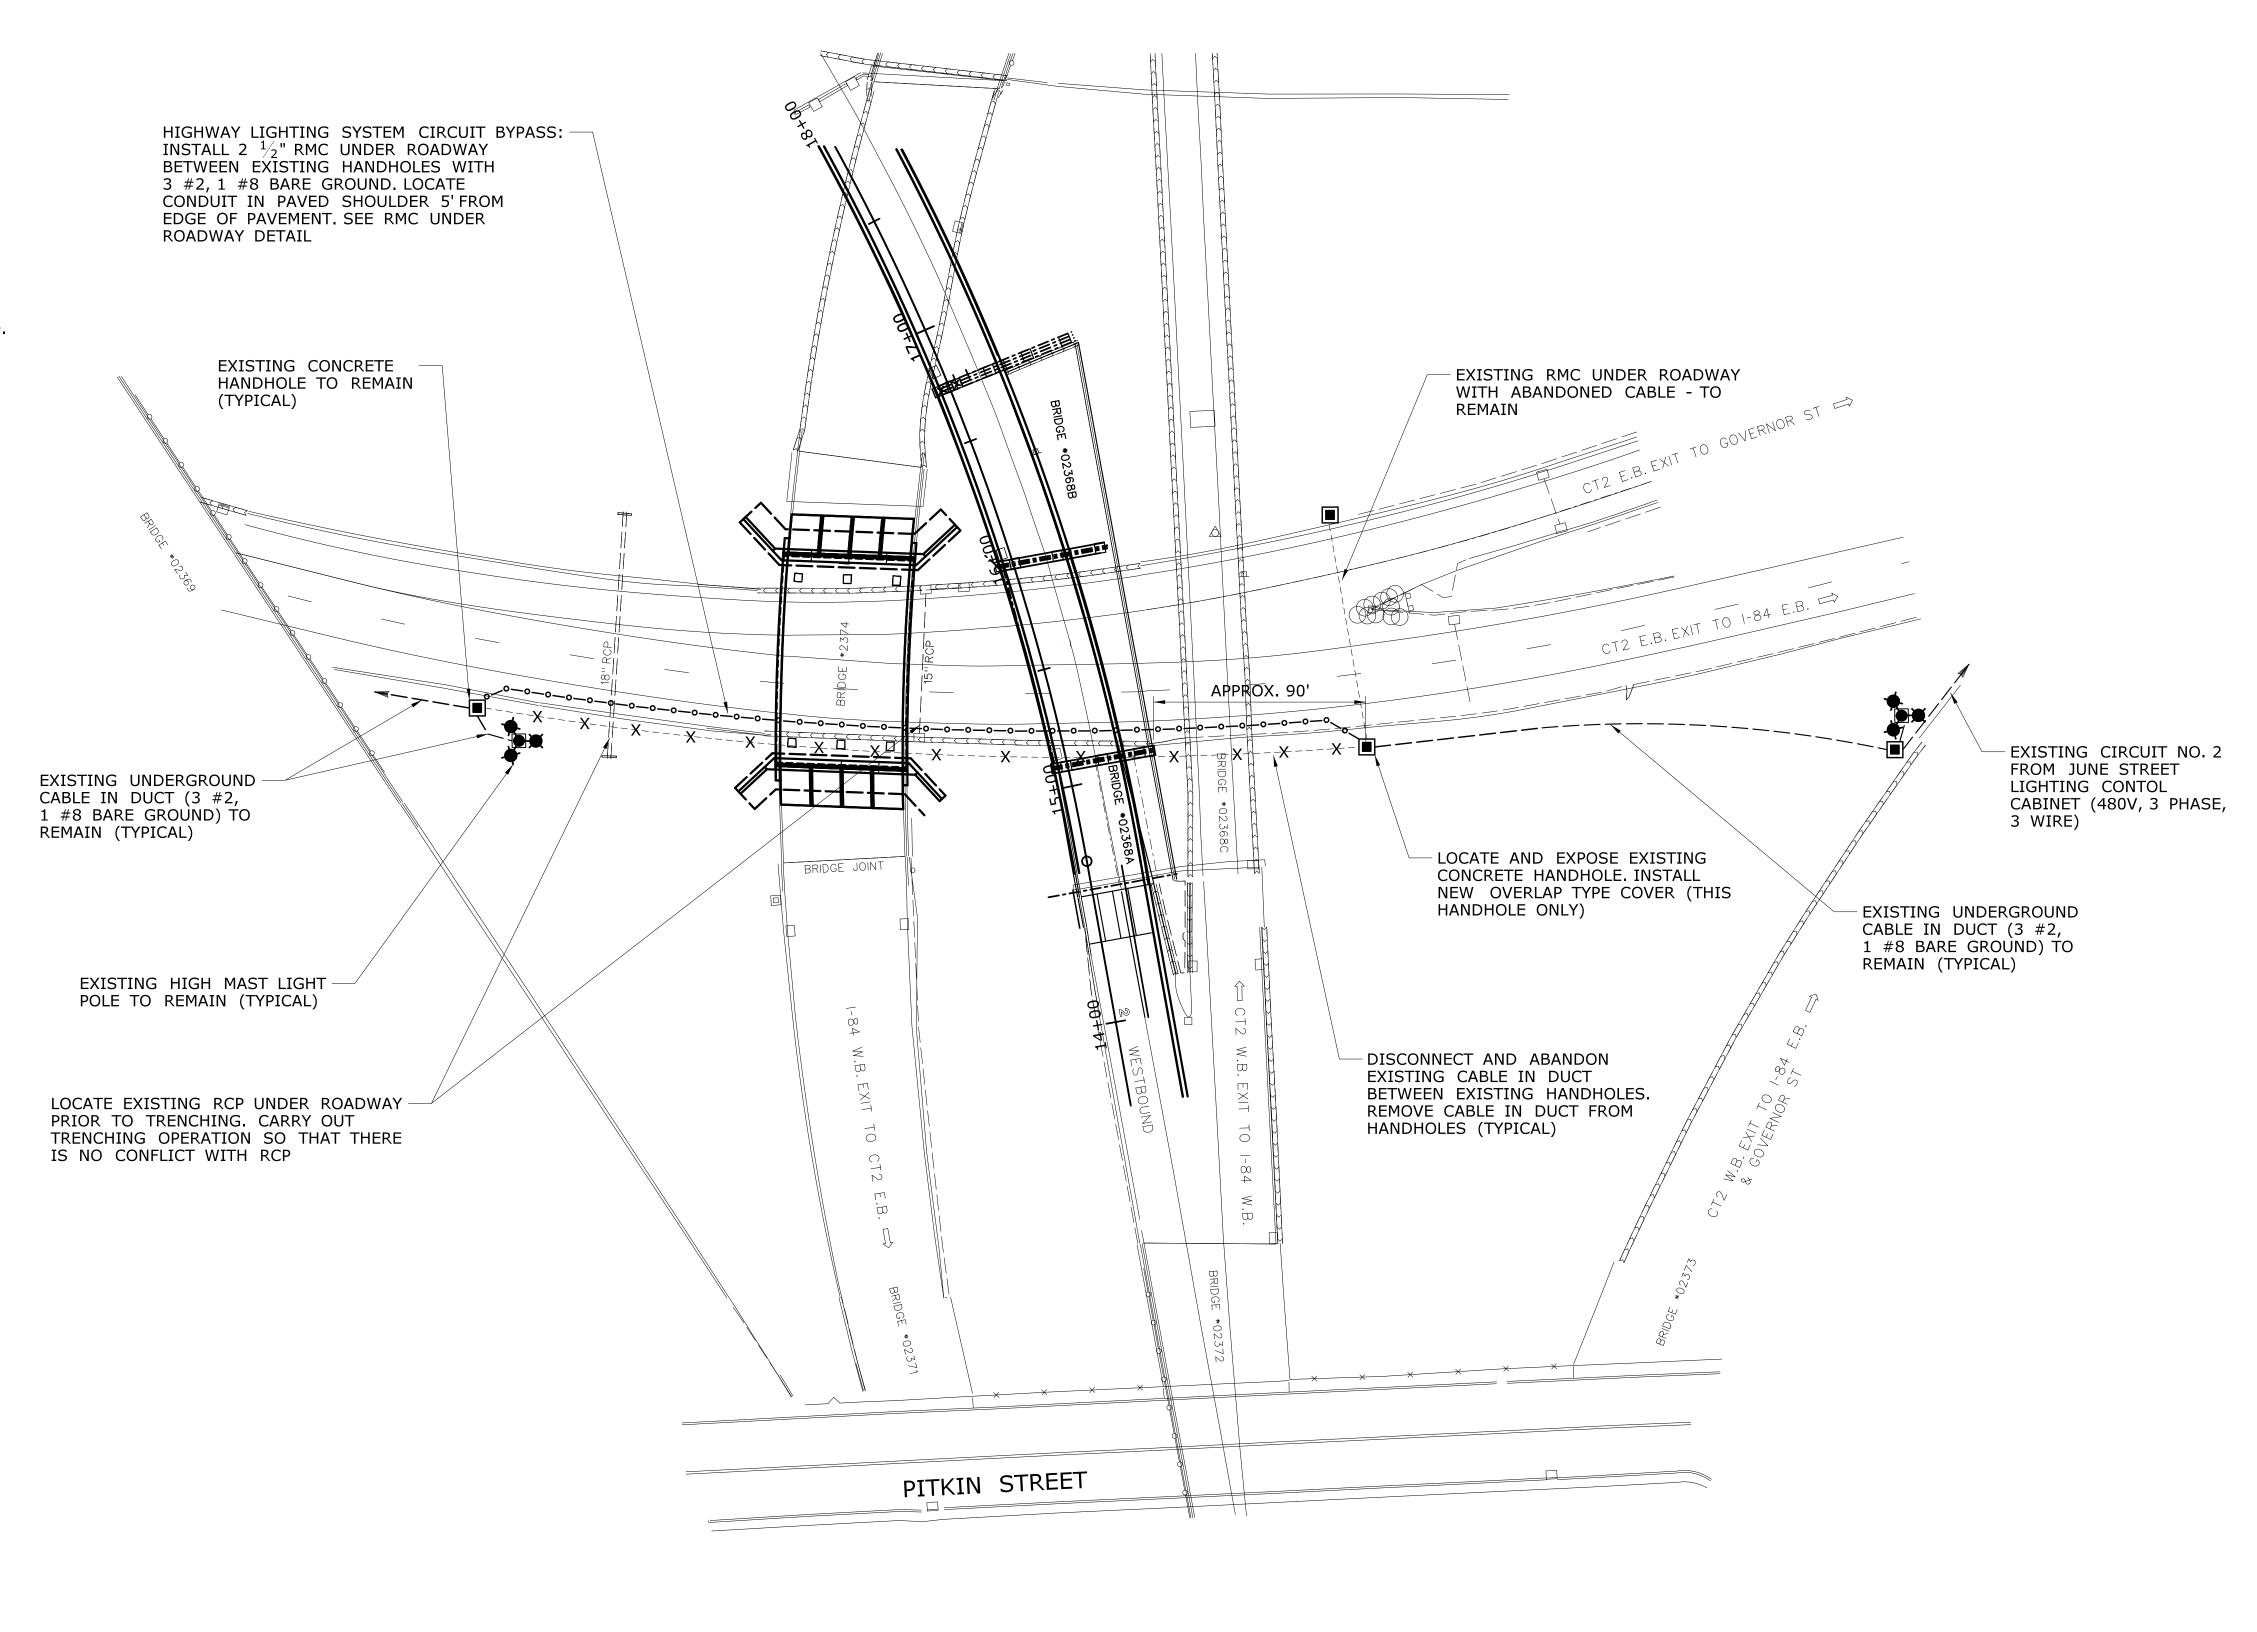

				THE INFORMATION, INCLUDING ESTIMATED QUANTITIES OF WORK, SHOWN ON THESE SHEETS IS BASED ON LIMITED INVESTIGATIONS BY THE STATE AND IS IN NO WAY WARRANTED TO INDICATE THE CONDITIONS OF ACTUAL QUANTITIES OF WORK WHICH WILL BE REQUIRED.
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SCALE IN FEET

SCALE 1"=40'


OFFICE OF ENGINEERING

APPROVED BY:


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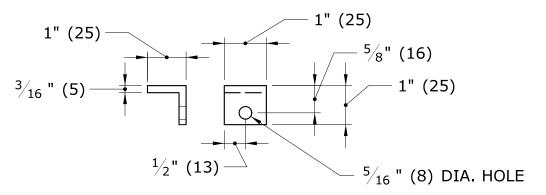
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		DRAWING NO.  TLL-02
≀AWING	ILLUMINATION	SHEET NO. <b>01.06.02</b>



## **CONDUIT TERMINATION AT HANDHOLE**

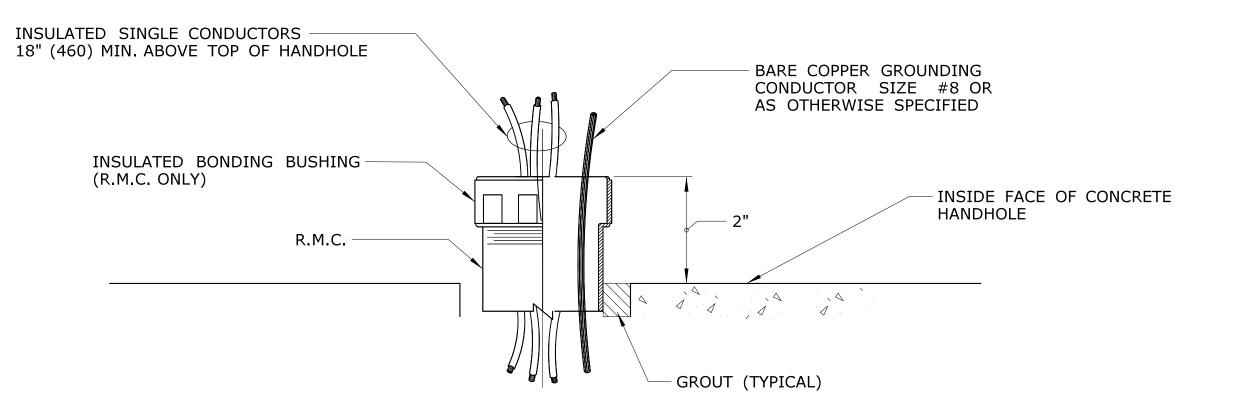


# **R.M.C. UNDER ROADWAY**

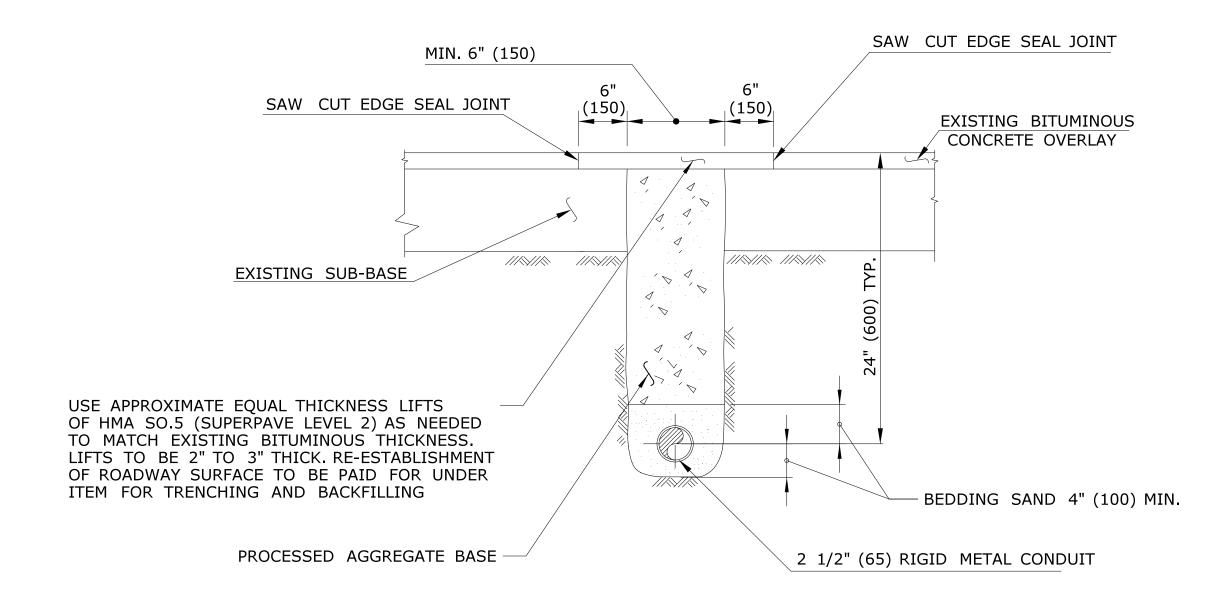


NOTE: ATTACH 72" (1830) LENGTH OF NO. 8 GROUND WIRE TO GROUNDING TAB WITH ONE HOLE LUG,  $^{1}_{4}$ " (M6) x  $^{3}_{4}$ " (20) LG. SST HEX HEAD BOLT, AND SST FLAT WASHER. ATTACH FREE END OF GROUND WIRE TO NO. 8 BARE GROUND WIRE IN HANDHOLE.

STEEL GROUNDING TAB

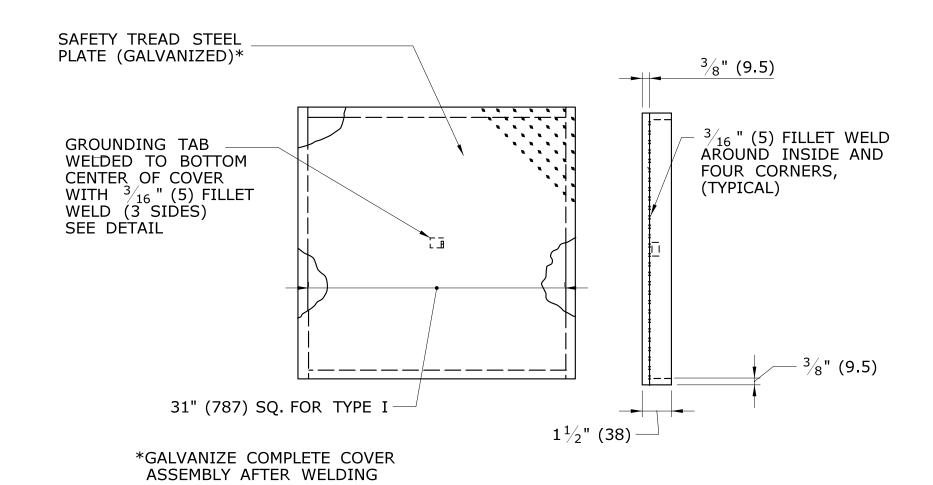


#### GALVANIZED STEEL HANDHOLE COVER

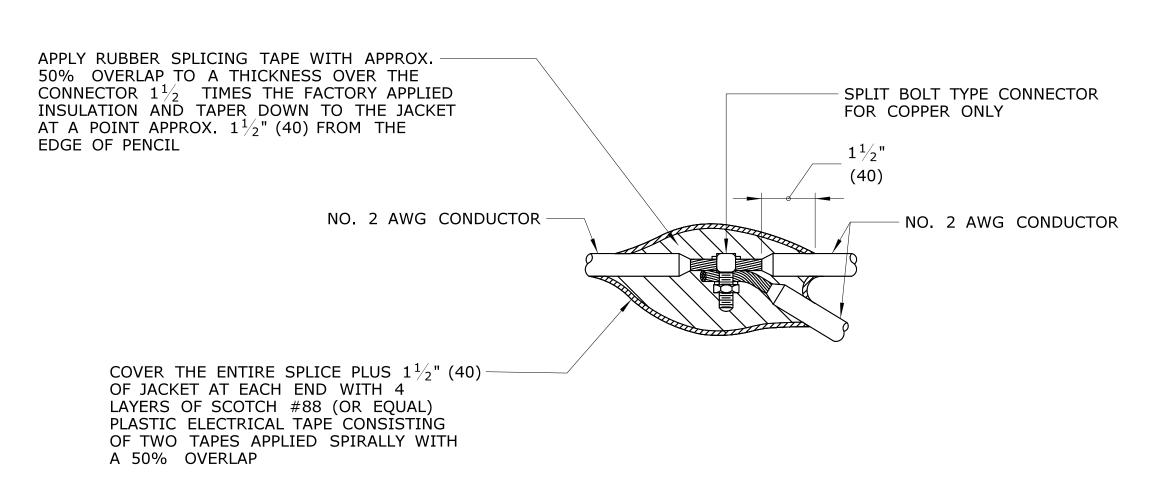


#### CABLE SPLICE

	THE INFORMATION, INCLUDING ESTIMATED QUANTITIES OF WORK, SHOWN ON THESE SHEETS IS BASED ON LIMITED INVESTIGATIONS BY THE STATE AND IS IN THE STATE	STATE OF CONNECTICUT	SIGNATURE/ BLOCK:  OFFICE OF ENGINEERING		EAST HARTFORD	DRAWING NO.  ILL-03
REV. DATE REVISION DESCRIPTION SHEET NO.	THE CONDITIONS OF ACTUAL QUANTITIES OF WORK WHICH WILL BE REQUIRED.  Plotted Date: 11/14/2014  NO SCALE	DEPARTMENT OF TRANSPORTATION  Filename:\Elec\_eng_data\ILL-02.dgn	ISSUE DATE: 6/6/14	NO. 02374 SR 500 TR 805 OVER I-84 TR 831 & TR 833	ELECTRICAL DETAILS	SHEET NO. <b>01.06.03</b>

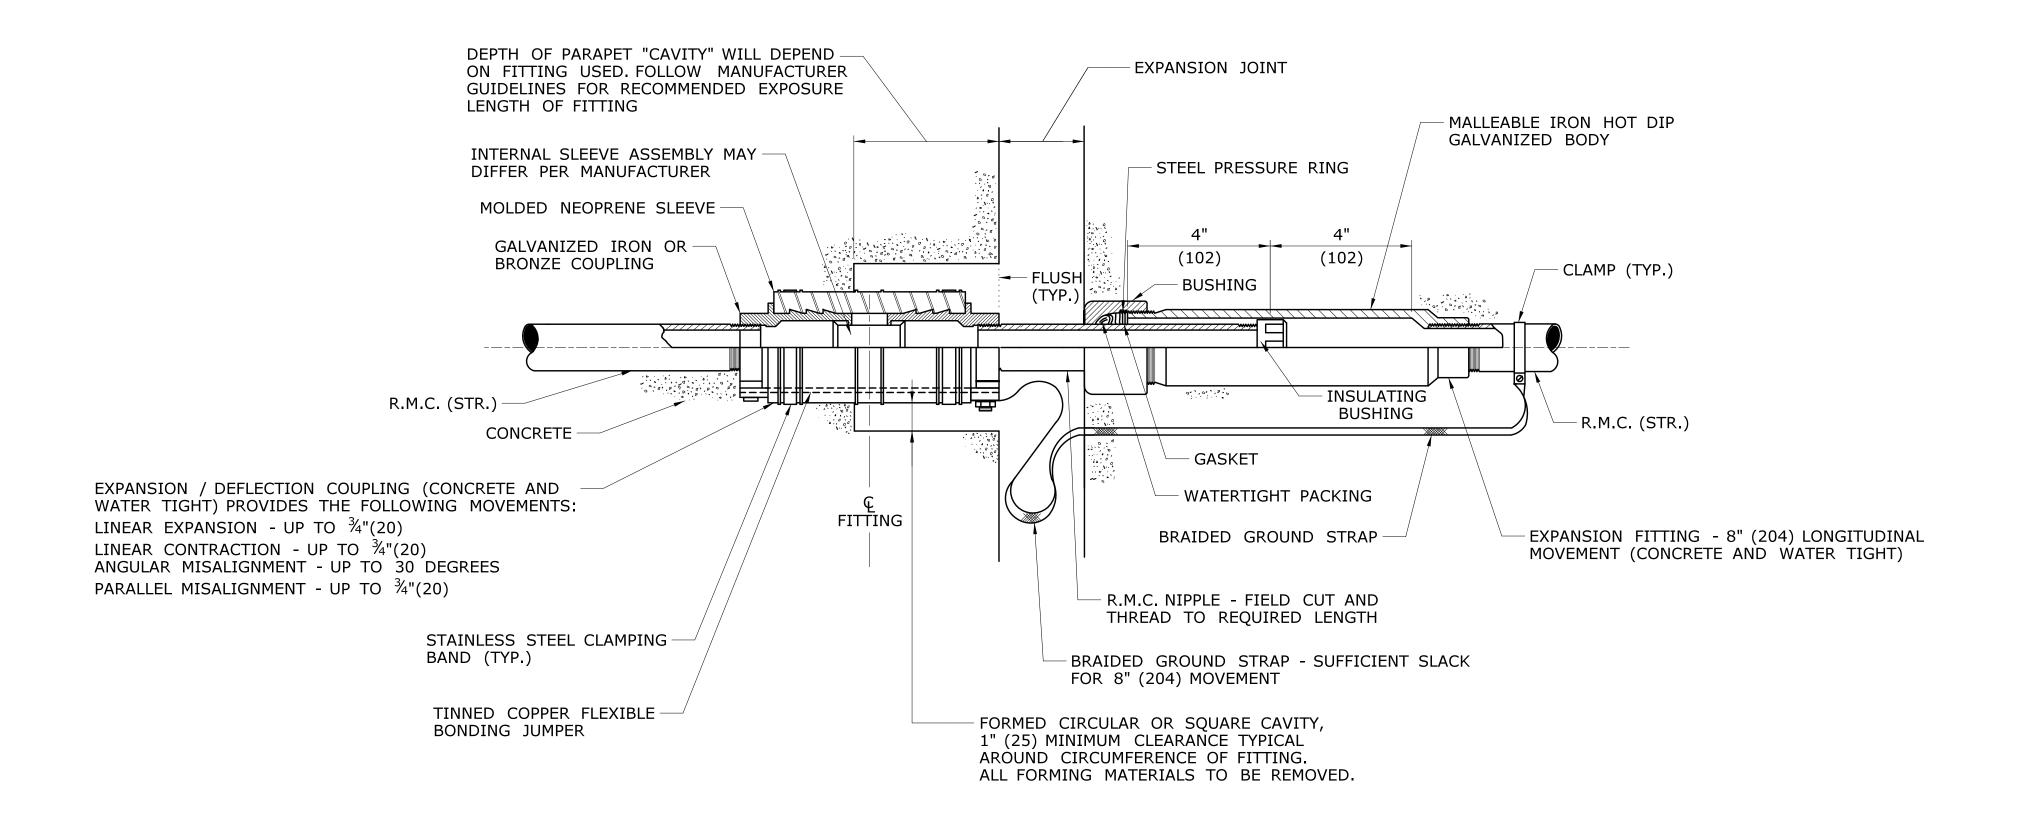

#### **EXPANSION FITTING TYPE 2**

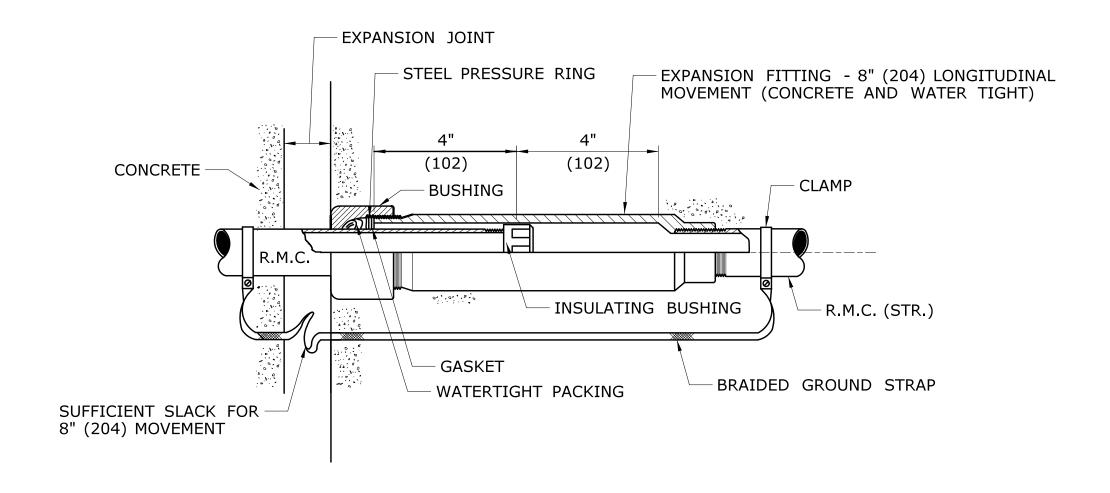

### **EXPANSION FITTING TYPE 1**

#### **NOTES:**

- 1) TYPE 1 CONDUIT EXPANSION FITTINGS SHALL BE REQUIRED AT ALL EXPANSION JOINT LOCATIONS IN CAST-IN-PLACE CONCRETE RETAINING WALLS SHARING COMMON PILE SUPPORTED FOOTINGS.
- 2) TYPE 2 CONDUIT EXPANSION FITTINGS SHALL BE REQUIRED AT ALL BRIDGE EXPANSION JOINTS. TYPE 2 CONDUIT EXPANSION FITTINGS ARE SUITABLE AT ALL BRIDGE JOINT LOCATIONS WITH TOTAL LONGITUDINAL THERMAL MOVEMENTS OF 8" (200mm) OR LESS AND TRANSVERSE MOVEMENTS OF 1.5" (38mm) OR LESS.
- 3) TYPE 2 CONDUIT EXPANSION FITTINGS SHALL BE REQUIRED AT ALL EXPANSION JOINT LOCATIONS IN CAST-IN-PLACE RETAINING WALLS WHERE THE FOUNDATION TRANSITIONS FROM A PILE SUPPORTED FOUNDATION TO A SPREAD FOOTING FOUNDATION.
- 4) ORIENTATION OF CONDUIT EXPANSION FITTING SHALL BE FIELD DETERMINED.

THE INFORMATION, INCLUDING ESTIMATED OUANTITIES OF WORK SHOWN ON THESE	DESIGNER/DRAFTER:  MSB	CONNECTICAL	SIGNATURE/ BLOCK:	PROJECT TITLE:	EAST HARTFORD	PROJECT NO. <b>042-304</b>
SHEETS IS BASED ON LIMITED INVESTIGATIONS BY THE STATE AND IS IN NO WAY WARRANTED TO INDICATE	JA	STATE OF CONNECTICUT	OFFICE OF ENGINEERING	REPLACEMENT OF BRIDGE NO. 02374 SR 500 TR 805		DRAWING NO.  ILL-04
THE CONDITIONS OF ACTUAL QUANTITIES OF WORK WHICH WILL BE REQUIRED.	NO SCALE	DEPARTMENT OF TRANSPORTATION	APPROVED BY:	OVER I-84 TR 831 & TR 833	CONDUIT EXPANSION	SHEET NO.
DEV DATE DEVISION DESCRIPTION SHEET NO Plotted Date: 11/14/2014	NO SCALE	Filename: \FINAL PLAN SET\ILL-04 dan	ISSUE DATE: 6/6/14		FITTINGS	01.06.04

